Attachment L

Revised Lighting Plan


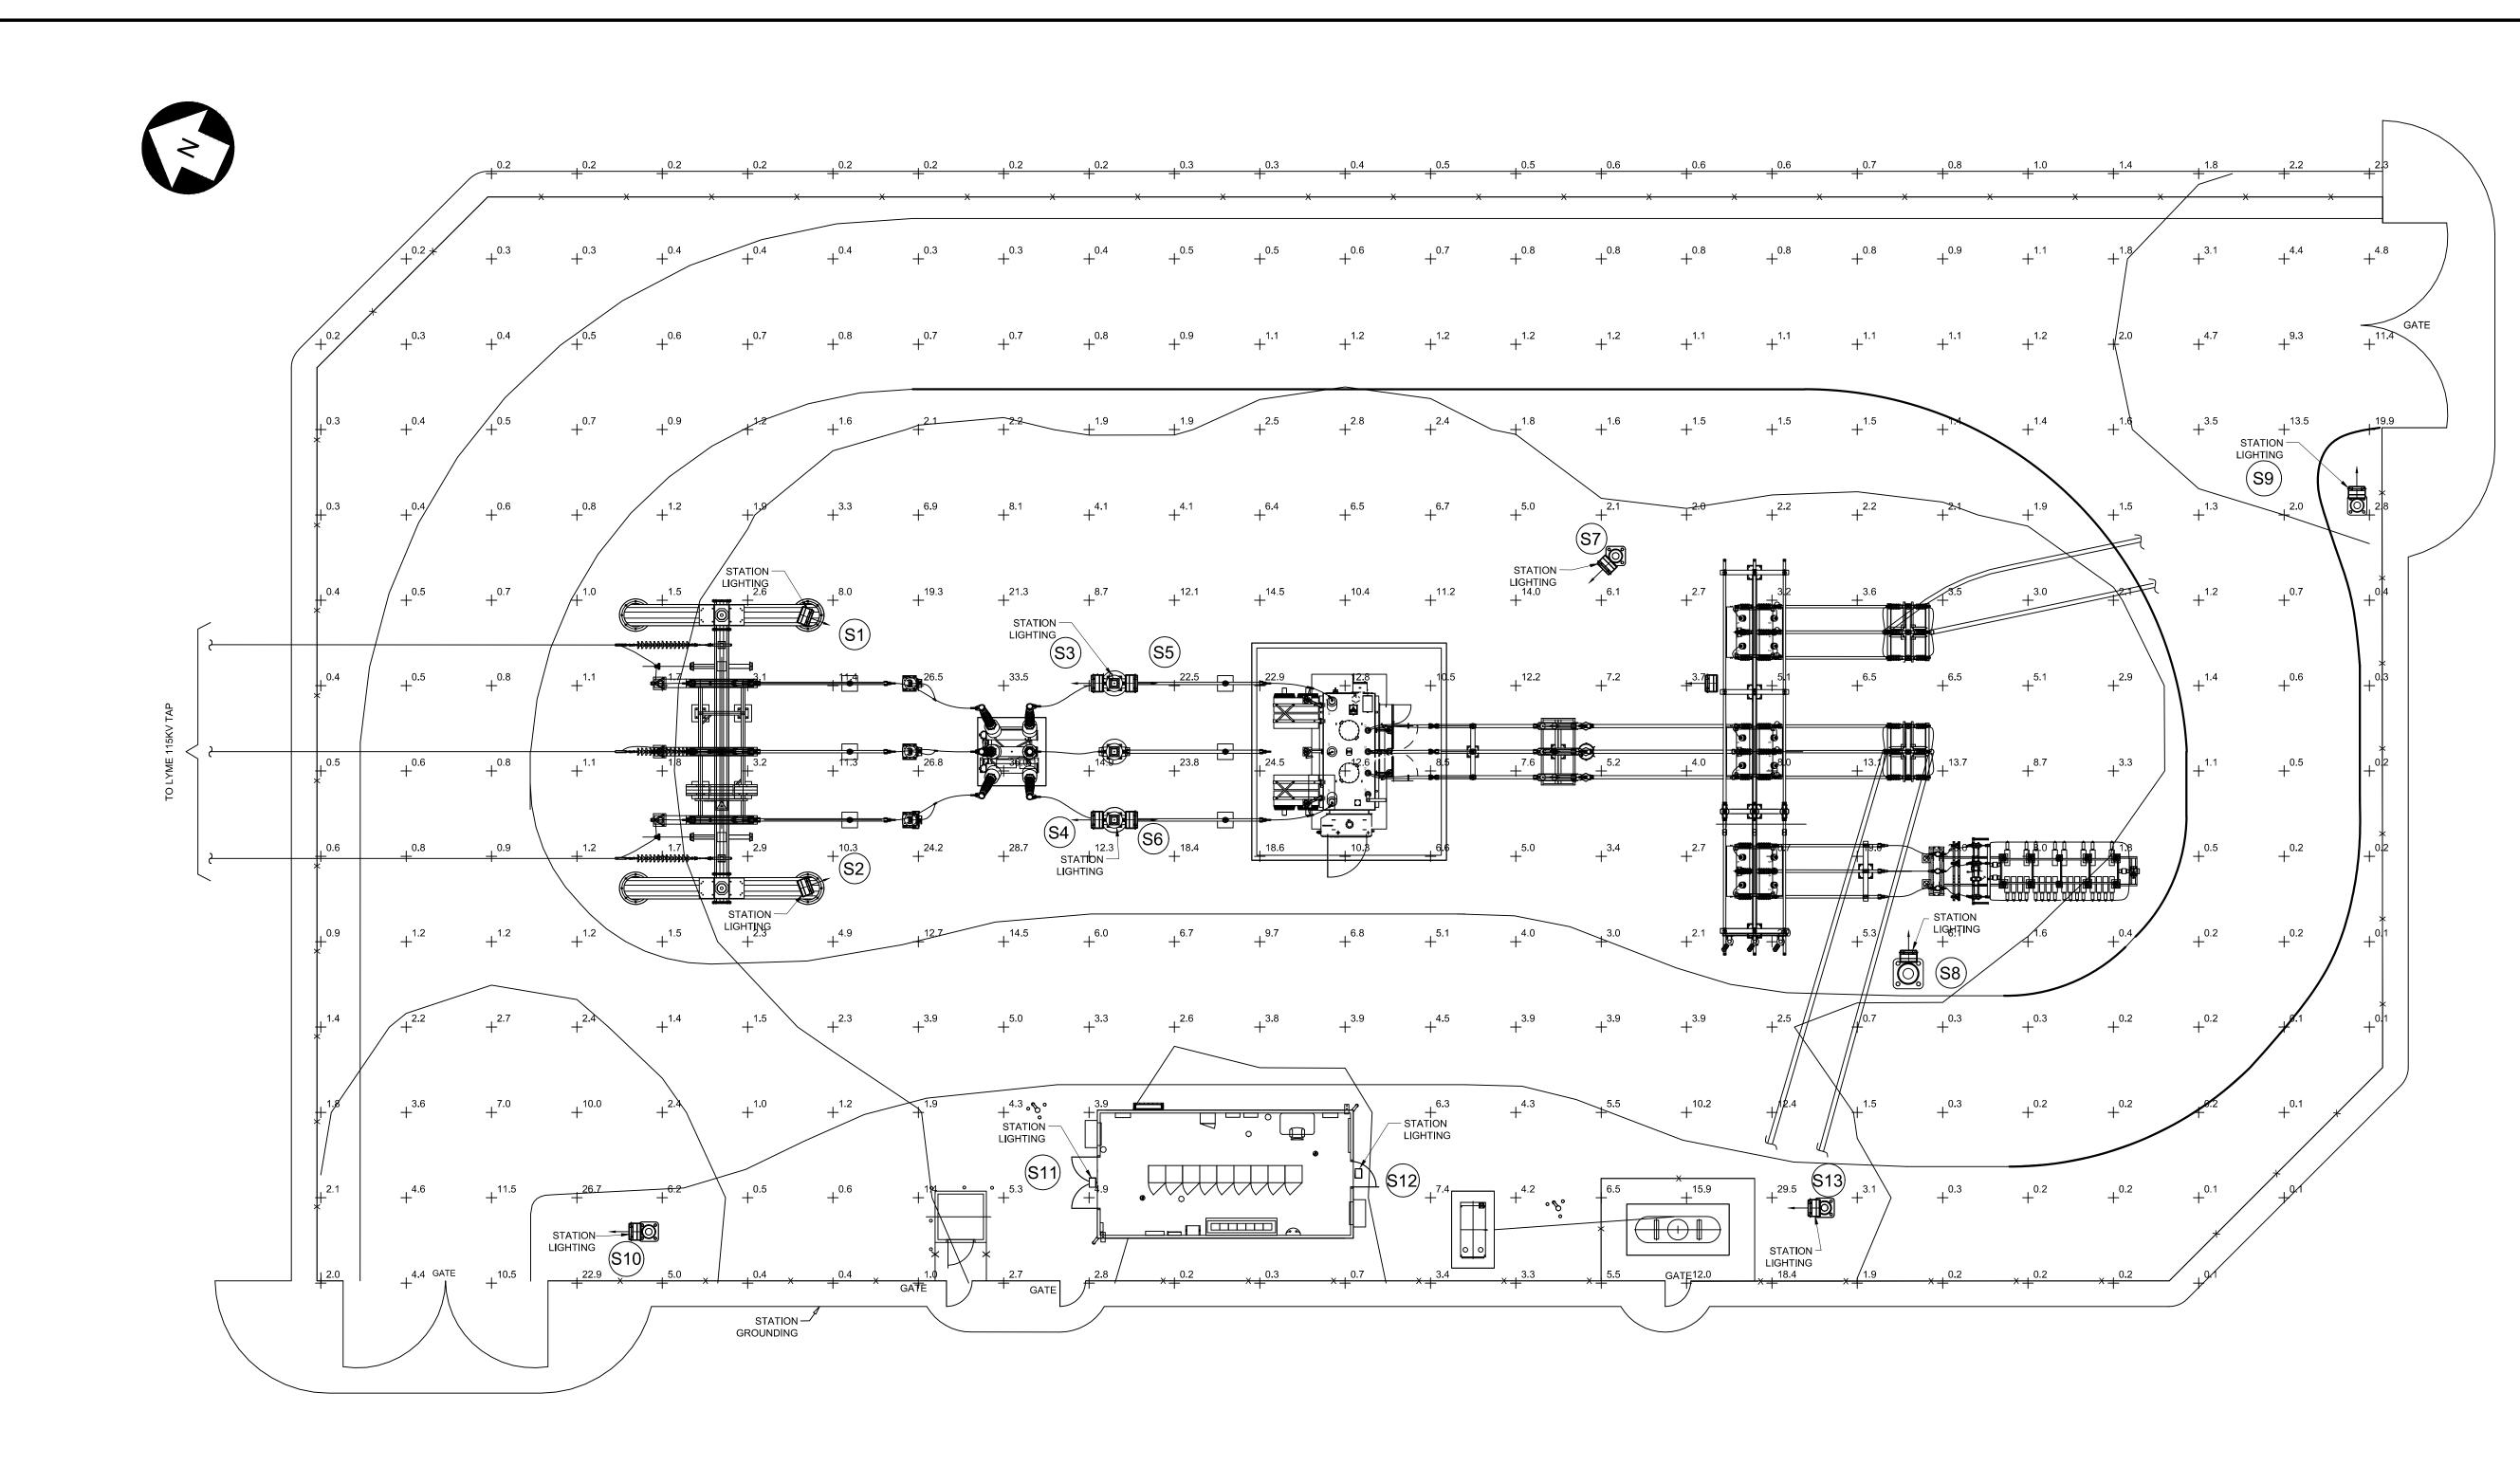


					TABLE 1	- LIGHTING FIXT	JRE SCHEDULE	
		FIXT	URE			LAMP	PHOTO-ELECTRIC CONTROL	
TYPE	WATTAGE	LIGHT SOURCE	VOLTAGE	WEIGHT (LBS)	LUMENS	NEMA CLASS	MANUFACTURER (GE) ITEM #	MANUFACTURER ITEM #
A1	25W	LED	120V	9.5	2,900	N/A	GE EVOLVE EWAS011A3730N	N/A
A3	150W	LED	120V	26	18,800	7X6	GE EVOLVE EFH101AA76740 W/ TOP & SIDE VISOR TSDKBZ-EFH	N/A
A5	297W	LED	120V	26	37,800	7X6	GE EVOLVE EFH101EE76740 W/ TOP & SIDE VISOR TSDKBZ-EFH	N/A

UNDER NEW YORK STATE EDUCATION LAW ARTICLE 145 (ENGINEERING), SECTION 7209 (2), IT IS A VIOLATION OF THE LAW FOR ANY PERSON, UNLESS ACTING UNDER THE DIRECTION OF A LICENSED PROFESSIONAL ENGINEER, TO ALTER THIS DOCUMENT.

FIXTURE SCHEDULE										
LIGHT NO.	TYPE	TILT ANGLE	WATTAGE	VOLTAGE						
S1	A3	75°	150W	120VAC						
S2	A3	75°	150W	120VAC 120VAC						
S3	A3	60°	150W							
S4	A3	60°	150W	120VAC						
S5	A3	60°	150W	120VAC						
S6	A3	60°	150W	120VAC						
S7	A3	75°	150W	120VAC						
S8	A5	75°	297W	120VAC						
S9	A3	45°	150W	120VAC						
S10	A3	45°	150W	120VAC						
S11	A1	0°	25W	120VAC						
S12	A1	0°	25W	120VAC						
S13	A3	45°	150W	120VAC						

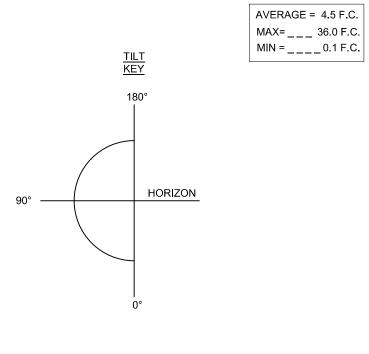

- NOTES: STATION LIGHTING IS COMPRISED OF (2) 25W, (10) 150W, AND (1) 297 W, 120V AC LED FLOODLIGHTS.
- LIGHT FIXTURES TO BE MOUNTED ON INDICATED STRUCTURES 15' ABOVE FINISHED GRADE. THE FIXTURES SHALL BE AIMED AS SHOWN ON THE DRAWING AND HAVE A TILT ANGLE BASED ON THE FIXTURE SCHEDULE.
- 3. YARD CONTOURS ARE 2.0 FT CANDLES (F.C.) FOR THIS STATION. 2 FT CANDLES IS THE EQUIVALENT OF 22 LUMENS PER SQUARE METER.

FLOODLIGHTS INSTALLED WITH TOP AND SIDE VISORS ACHIEVE FULL CUTOFF REQUIREMENT (0 F.C.) ABOVE FIXTURE.





aes
2180 South 1300 East, Suite 600 Salt Lake City, UT 84106-2749 (801) 679 - 3500
249 Western Avenue Augusta, ME 04330
PE STAMP:
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KEY PLAN:
REVISIONS: NO. DATE DESCRIPTION
NO.DATEDESCRIPTION108/05/2021ISSUED FOR PERMIT
2 09/10/2021 ISSUED FOR PERMIT
3 01/21/2022 ISSUED FOR PERMIT
PROJECT TITLE:
RIVERSIDE SOLAR COLLECTION SUBSTATION 115KV-34.5KV PROJECT LOCATION:
TOWNS OF LYME & BROWNVILLE JEFFERSON CO., NY
SHEET TITLE & DESCRIPTION:
GENERAL ARRANGEMENT
LIGHTING PLAN
PROJ 422208
DES: D. FARRELL
DWN: D. FARRELL
CHK: C. PASCALE
APV: C. PASCALE
DATE: 04/15/2021
SCALE AT 22" x 34": 0 4' 8' 16' 24'
3/32" = 1'-0"
SHEET NO: REV: HV-P.13.01 3

UNDER NEW YORK STATE EDUCATION LAW ARTICLE 145 (ENGINEERING), SECTION 7209 (2), IT IS A VIOLATION OF THE LAW FOR ANY PERSON, UNLESS ACTING UNDER THE DIRECTION OF A LICENSED PROFESSIONAL ENGINEER, TO ALTER THIS DOCUMENT.

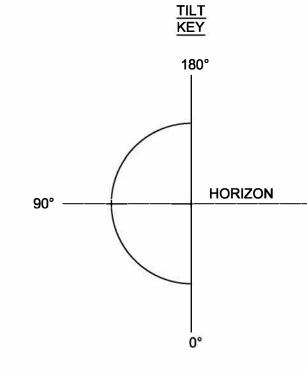


					TABLE 1 - LIG		SCHEDULE (NO	DTE 2)	
		FIXT	URE			LAMP	PHO		
TYPE	WATTAGE	LIGHT SOURCE	VOLTAGE	WEIGHT (LBS)	LUMENS	NEMA CLASS	TILT ANGLE	MANUFACTURER (GE) ITEM #	MANU
A3	150W	LED	120V	26	18,800	7X6	60°	GE EVOLVE EFH101AA76740 W/ TOP & SIDE VISOR TSDKBZ-EFH	

+0	.6 +0.8	+ ^{1.1}	+ ^{1.4}	+1.9	+2.4	+2.7	+ ^{2.9}	+2.6	+1.6	+ ^{0.6}	+0.2	+0.0	+0.0	
+0	.7 +0.9	+ ^{1.3}	+1.7	+2.5	+ ^{3.4}	+ ^{4.6}	+ ^{5.7}	+ ^{5.9}	+4.2	+1.5	+0.4	+ ^{0.1}	+ ^{0.0}	
+0	.8 + ^{1.0}	+ ^{1.4}	+2.1	+ ^{3.1}	+4.5	+ ^{6.7}	+ ^{9.6}	+ ^{12.5}	+ ^{10.6}	+3.5	+0.9	+ ^{0.1}	+ ^{0.0}	
+0	.8 ₊ 1.1	+ ^{1.6}	+2.3	+ ^{3.6}	+ ^{5.5}	+ ^{8.6}	+ ^{13.5}	+ ^{19.8}	+20.5	+7.1	+1.7	+ ^{0.2}	+0.0	
							S	TATION LIG			<u></u> √−LIGŀ	ITING DESIG	NATION STATION ROA	D
 0	8 12	17	2.5	3.8	6.0	0.8	16 1	25.2	27.9	10.0		0.2		
+0	.8 + ^{1.2}	+ ^{1.7}	+2.3	+3.8	+ ^{6.0}	+ ^{9.8}	+ ^{16.1}	+25.2	+27.9		(SX)+ ^{2.3}	+ ^{0.2}	+ ^{0.0}	
	.8 +1.2		+2.4	+ ^{3.8}	+ ^{5.9}	A + ^{9.5}	+ ^{15.6}	+24.0				+0.2	+0.0	
						$/ \setminus$		•				STATI	ON FENCE	
+0	.8 + ^{1.1}	+ ^{1.5}	+2.3	+ ^{3.4}	+5.2	+8,1	+ ^{12.4}	+17.6	+ ^{17.7}	+ ^{6.0}	/+ ^{1.5}	+0.2	+0.0	
+0	.7 + ^{1.0}	+ ^{1.4}	2.0	+2.9	+4.2	+6.0	+8.4	+10.3	+8.1	2.7	+ ^{0.7}	+ ^{0.1}	+0.0	
+	+	+	*	+	+	+	+	+	+	*	GATE S	+ SIZE VARIES TE SHOWN)	+	
+0	.7 _0.9	+ ^{1.2}	+1.6	+2.3	+ ^{3.1}	+4.1	+4.6	+4.7	+ ^{3.2}	+1.1	+0.3	+0.0	+0.0	
			,	\backslash							IGHTING CO			
0	.60.8	1.0	13	17	2.1	23	24	120	12	0.5	0.2	0.0	0.0	
+0	+	+ ^{1.0}	+ ^{1.3}	+1.7	4	+ ^{2.3}	+2.4		+ ^{1.2}	+ ^{0.5}	+0.2	+0.0	+0.0	
+0	.5 +0.6	+0.8	+1.0	+ ^{1.1}	+ ^{1.3}	+ ^{1.3}	+ ^{1.1}	+0.9	+0.6	+0.2	+0.1	+0.0	+0.0	
						SCALE:	3/16" = 1'-0"							
+0	.4 _0.5	+0.6	+0.7	+0.7	+0.8	+0.7	+0.6	+0.4	+0.3	+0.1	+0.0	+0.0	+0.0	
+	+	+	+	+	+	+	+	+	+	+	+	+	+	

IOTO-ELECTRIC CONTROL ANUFACTURER ITEM # N/A

NOTES:

aes								
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1 08/05/2021 ISSUED FOR PERMIT								
2 09/10/2021 ISSUED FOR PERMIT 3 01/21/2022 ISSUED FOR PERMIT								
4 02/03/2022 ISSUED FOR PERMIT								
PROJECT TITLE:								
RIVERSIDE SOLAR PROJECT								
PROJECT LOCATION:								
TOWNS OF LYME AND BROWNVILLE, NY								
SHEET TITLE & DESCRIPTION:								
PV ENTRANCE GATE LIGHTING								
LIGHTING DETAIL								
PROJ 422208								
DES: D. FARRELL								
DWN: D. FARRELL								
CHK: C. PASCALE								
APV: C. PASCALE								
DATE: 05/21/21 SCALE AT 22" x 34":								
SCALE AT 22" x 34": 0 2' 4' 8' 12'								
3/16" = 1'-0" SHEET NO: REV: PV-C.08.03 4								
PV-C.08.03 I 4								

1. ENTRANCE GATE LIGHTING IS COMPRISED OF (1) 150W,120V AC LED FLOODLIGHT PER GATE. THIS GATE DETAIL IS APPLICABLE TO ALL PV YARD AND O&M YARD GATES. (12) PV YARD GATES AND (1) O&M YARD GATE. A TOTAL OF (13) FIXTURES ARE REQUIRED.

2. LIGHT FIXTURES TO BE MOUNTED ON INDICATED STRUCTURES 15' ABOVE FINISHED GRADE. THE FIXTURES SHALL BE AIMED AS SHOWN ON THIS DRAWING AND HAVE A TILT ANGLE BASED ON THE FIXTURE SCHEDULE.

3. LIGHTING CONTOUR IS 2 FT CANDLES (F.C.) AVERAGE FOR THIS YARD.

4. FLOODLIGHTS INSTALLED WITH TOP AND SIDE VISORS ACHIEVE FULL CUTOFF REQUIREMENT (0 F.C.) ABOVE FIXTURE.

5. GATE LIGHTS SHALL BE CAPABLE OF MANUAL SHUT-OFF.



